## City of Prineville Conditional Use Permit Application Review and Burden of Proof

Prepared for

City of Prineville Planning Department 387 NE Third Street Prineville, OR 97754

Prepared by

**Parametrix** 150 NW Pacific Park Lane, Suite 110 Bend, OR 97701 T. 541.508.7710 F. 1.855.542.6353 www.parametrix.com

## CITATION

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### 1. **PROJECT OVERVIEW**

Applicant	Vitesse, LLC
Representative	Greg Smith, PE; Parametrix
Site Address	511 SW Connect Way, Prineville OR 97754
Taxlot	1515010001102
Zoning	M-1 Light Industrial
Review	Type II Conditional Use Review


## 2. PROJECT AND SITE DESCRIPTION

The applicant is proposing updates to the existing PRN1 building located on the southern end of the data center campus. The subject building is the far west PRN building, taxlot 1515010001102, located on 32.40 acres. The project site is located in M-1 Light Industrial zoning and is mainly surrounded by industrial uses to the south and west and park reserve zoning to the east.


The upgrades propose extending the existing building north, adding a new two-story addition. The new addition includes a maximum height of 57 feet, requiring a building height conditional use exception. The alterations will not be visible from the rim, located at least 2,000 feet away, and will be partially blocked from view by the existing data center buildings to the east.

Currently, a few small outbuildings and a paved circulation road are located north of the PRN1 building.

#### Figure 1 – Project Location

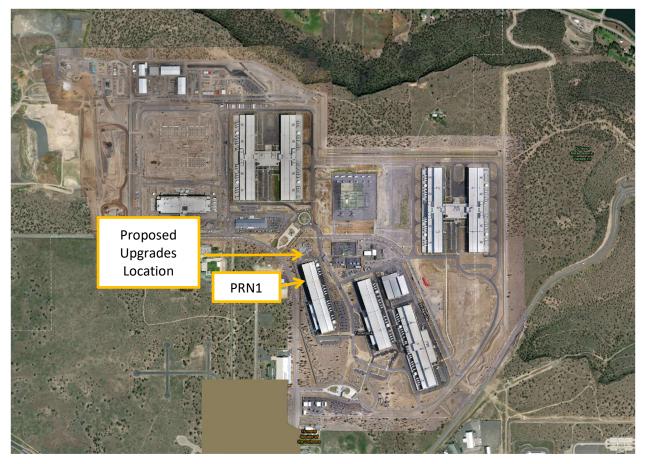

#### Figure 2 – Project Zoning

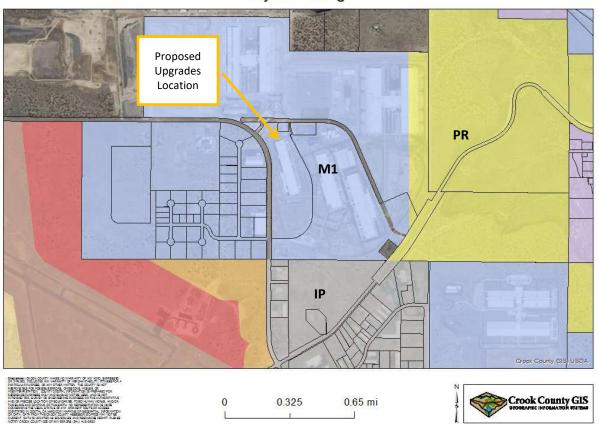

**Project Zoning** 

#### Figure 3 – Project Vicinity



**Project Vicinity** 

## **3.** APPROVAL CRITERIA

#### 153.137 Application for Conditional Use

A property owner or duly authorized agent may initiate a request for conditional use or the modification of an existing conditional use by filing an application with the city using forms prescribed therefor by the city. The standard application form shall be completed in its entirety and shall be accompanied by a site plan, drawn to scale, and showing the dimensions, arrangement and intended use of the proposed development. The application shall also be accompanied by a vicinity map showing the subject property, all properties within 100 feet and the names and addresses of all property owners within 100 feet as reported by the current County Assessor's records. If an application is submitted by any person or persons other than the property owner or authorized agent thereof, the application shall be jointly signed by the

owner or agent, or there shall be submitted an accompanying certified statement from the owner or agent attesting to the knowledge and approval of the submittal. An application shall not be deemed complete unless accompanied by the required filing fee established by the City Council by ordinance or resolution.

**Response:** The applicant is submitting a City of Prineville conditional use application accompanied by a site plan with the specified requirements, vicinity map with surrounding properties, and required filing fee.

#### C-1 C-2 C-4 C-5 M-1 M-2 IP C-3 Downtown General Professional Neighbor Recreational Light Heavy Ind. Park Clear Vision (ft.): See § 153.081 for more details. 25<sup>D</sup> 25 25<sup>D</sup> 25 25 25 25 25 Street intersection (measured from curb) Alley or ped. path 15 15 15 15 15 15 15 15 (measured from curb or edge) Landscaping (%): See § 153.087 for detailed requirements. Minimum<sup>F</sup> 0 10 10 10 10 **0**G 0<sup>G</sup> 10<sup>H</sup> Building Height (ft.): See § 153.118 for exceptions to height limits. 50 Maximum<sup>E</sup> 45 35 35 30 50 50 45 See § 153.191(C) for exceptions. Minimum Street Frontage (ft.): Standard street 20 50 50 50 50 50 50 50 20 Cul-de-sac 35 35 35 35 35 35 35 Maximum Lot Coverage: Impervious surface Determined by the ability to maintain drainage on site. Buildings Determined by the ability to meet parking, landscaping, clear vision, drainage, Public Works standards and other applicable dimensional standards. Minimum Lot Size (sq. ft.): Commercial/industrial Minimum lot size shall be determined on the basis of compliance with off-street parking, landscaping, those standards administered by Public Works and other applicable dimensional standards.

#### 153.038 Commercial and Industrial Dimensional Standards

	C-1	C-2	C-3	C-4	C-5	<mark>M-1</mark>	M-2	IP
	Downtown	General	Professional	Neighbor	Recreational	Light	Heavy	Ind. Park
Residential use	R-2	R-2	R-2	Adj. Zone	R-2	R-2	R-2	R-2
Permitted Residential	R-2 std.	R-2 std.	R-2 std.	N/A	R-2 std.	N/A	N/A	N/A

\*All dimensional standards subject to Building and Fire Department structural standards.

<sup>A</sup> Except that which may be needed to meet street and sidewalk right-of-way standards.

<sup>B</sup> Unless buildings are attached or constructed as one building.

<sup>c</sup> Subject to approval by Public Works and Engineering.

<sup>D</sup> Unless otherwise approved by the reviewing or jurisdictional authority.

<sup>E</sup> Building heights greater than standard shall be approved as a Type II conditional use.

<sup>F</sup> May require landscaping around buildings, in parking areas, outdoor recreation areas and screening and buffering purposes.

<sup>G</sup> Minimum five-foot buffer along any adjoining public right-of-way of a major collector or arterial street.

<sup>H</sup> Twenty-five percent of the area within 100 feet of an arterial or major collector street, five-foot minimum along street.

<sup>1</sup> Setbacks shall increase one foot for every foot of structural height over 35 feet.

**Response:** The subject property is zoned M-1, Light Industrial and currently classified with a building height standard of 50 feet. The applicant is requesting a Type II Conditional Use exception to allow a maximum building height of 57 feet. The increased height allowance allows for a two-story addition to the existing PRN1 building.

#### 153.118 Exceptions to Building Heights

(A) The following types of structures or structural parts are not subject to the building height limitations of this chapter: chimneys, cupolas, tanks, church spires, belfries, domes, derricks, monuments, fire and hose towers, observation towers, transmission towers, smokestacks, flagpoles, radio, cellular and television towers, masts, aerials, cooling towers, water towers, elevator shafts, windmills, conveyors, mill related apparatus and other similar projections.

**Response:** This exception does not apply to the subject property as the request is for the entirety of the building addition to potentially exceed the standard maximum height restriction.

(B) The exceptions to building height limitations set forth herein are not applicable to any such structures or structural parts that are located within an Airport Approach (AA) Overlay Zone.

**Response:** The subject property is not located within an Airport Approach overlay zone. This exception does not apply to the subject property.

## Exhibit A

FOR OFFICE USE ONLY
Application #:
Floodplain #
Date Received:
Zone:
CU type 1 Cu type 2



#### **City of Prineville Conditional Use Permit Application** PLEASE NOTE: INCOMPLETE APPLICATIONS <u>WILL NOT BE ACCEPTED</u>

#### PROPERTY OWNER AND APPLICANT INFORMATION

Applicant Name		Phone	/	
Address		City	State	Zip Code
	Email			
Proporty Owner		Phone	1	
		Phone		
Address		City	State	_ Zip Code
	Email			
Business Name		Phone	/	
Address		City	State	Zip Code
	Email			
	PR	OPERTY DESCRIP	TION	
Property address:				
Map # - Township _	Range	Section	Tax Lot	
Present Zoning	Total Lan	nd Area (Squ	uare Ft.)	
Present Land Use				

#### **PROPOSED USE**

	New Construction
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□ Residential

□ Multi-Family Dwelling

□ Addition

- □ Commercial
- □ Industrial

#### **Brief Description of Proposed Use:**

#### TO COMPLETE THIS APPLICATION, PLEASE SUBMIT THE FOLLOWING:

- $\Box$  Competed Application Form
- □ Burden of Proof
- □ Statement or general vicinity map indicating geographical location of property.
- Dimensioned Site Plan, drawn to scale, showing:
- $\Box$  Actual shape and dimensions of property
- $\Box$  The location and intended use of each building or structure.
- □ Building Setbacks
- □ Roads, streets or alleys, other infrastructure, easements, etc...
- □ Landscaping
- □ Parking

By signing this application, the undersigned certifies that he/she has read and understands the submittal requirements of the City's land use code. <u>Please note:</u> If the applicant makes a misstatement of fact on the application regarding ownership, authority to submit the application, acreage, or any other fact material relied upon in making a decision the Planning Director may upon notice to the applicant and subject to an applicant's right to a hearing declare the application void.

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Property Owner: \_\_\_\_\_

\_\_\_\_\_ Date: \_\_\_\_\_


Signature

Signature

Please note: additional information may be required by the Planning Department prior to the application being deemed complete.


Conditional Use Application Page 2 of 2

## Exhibit B

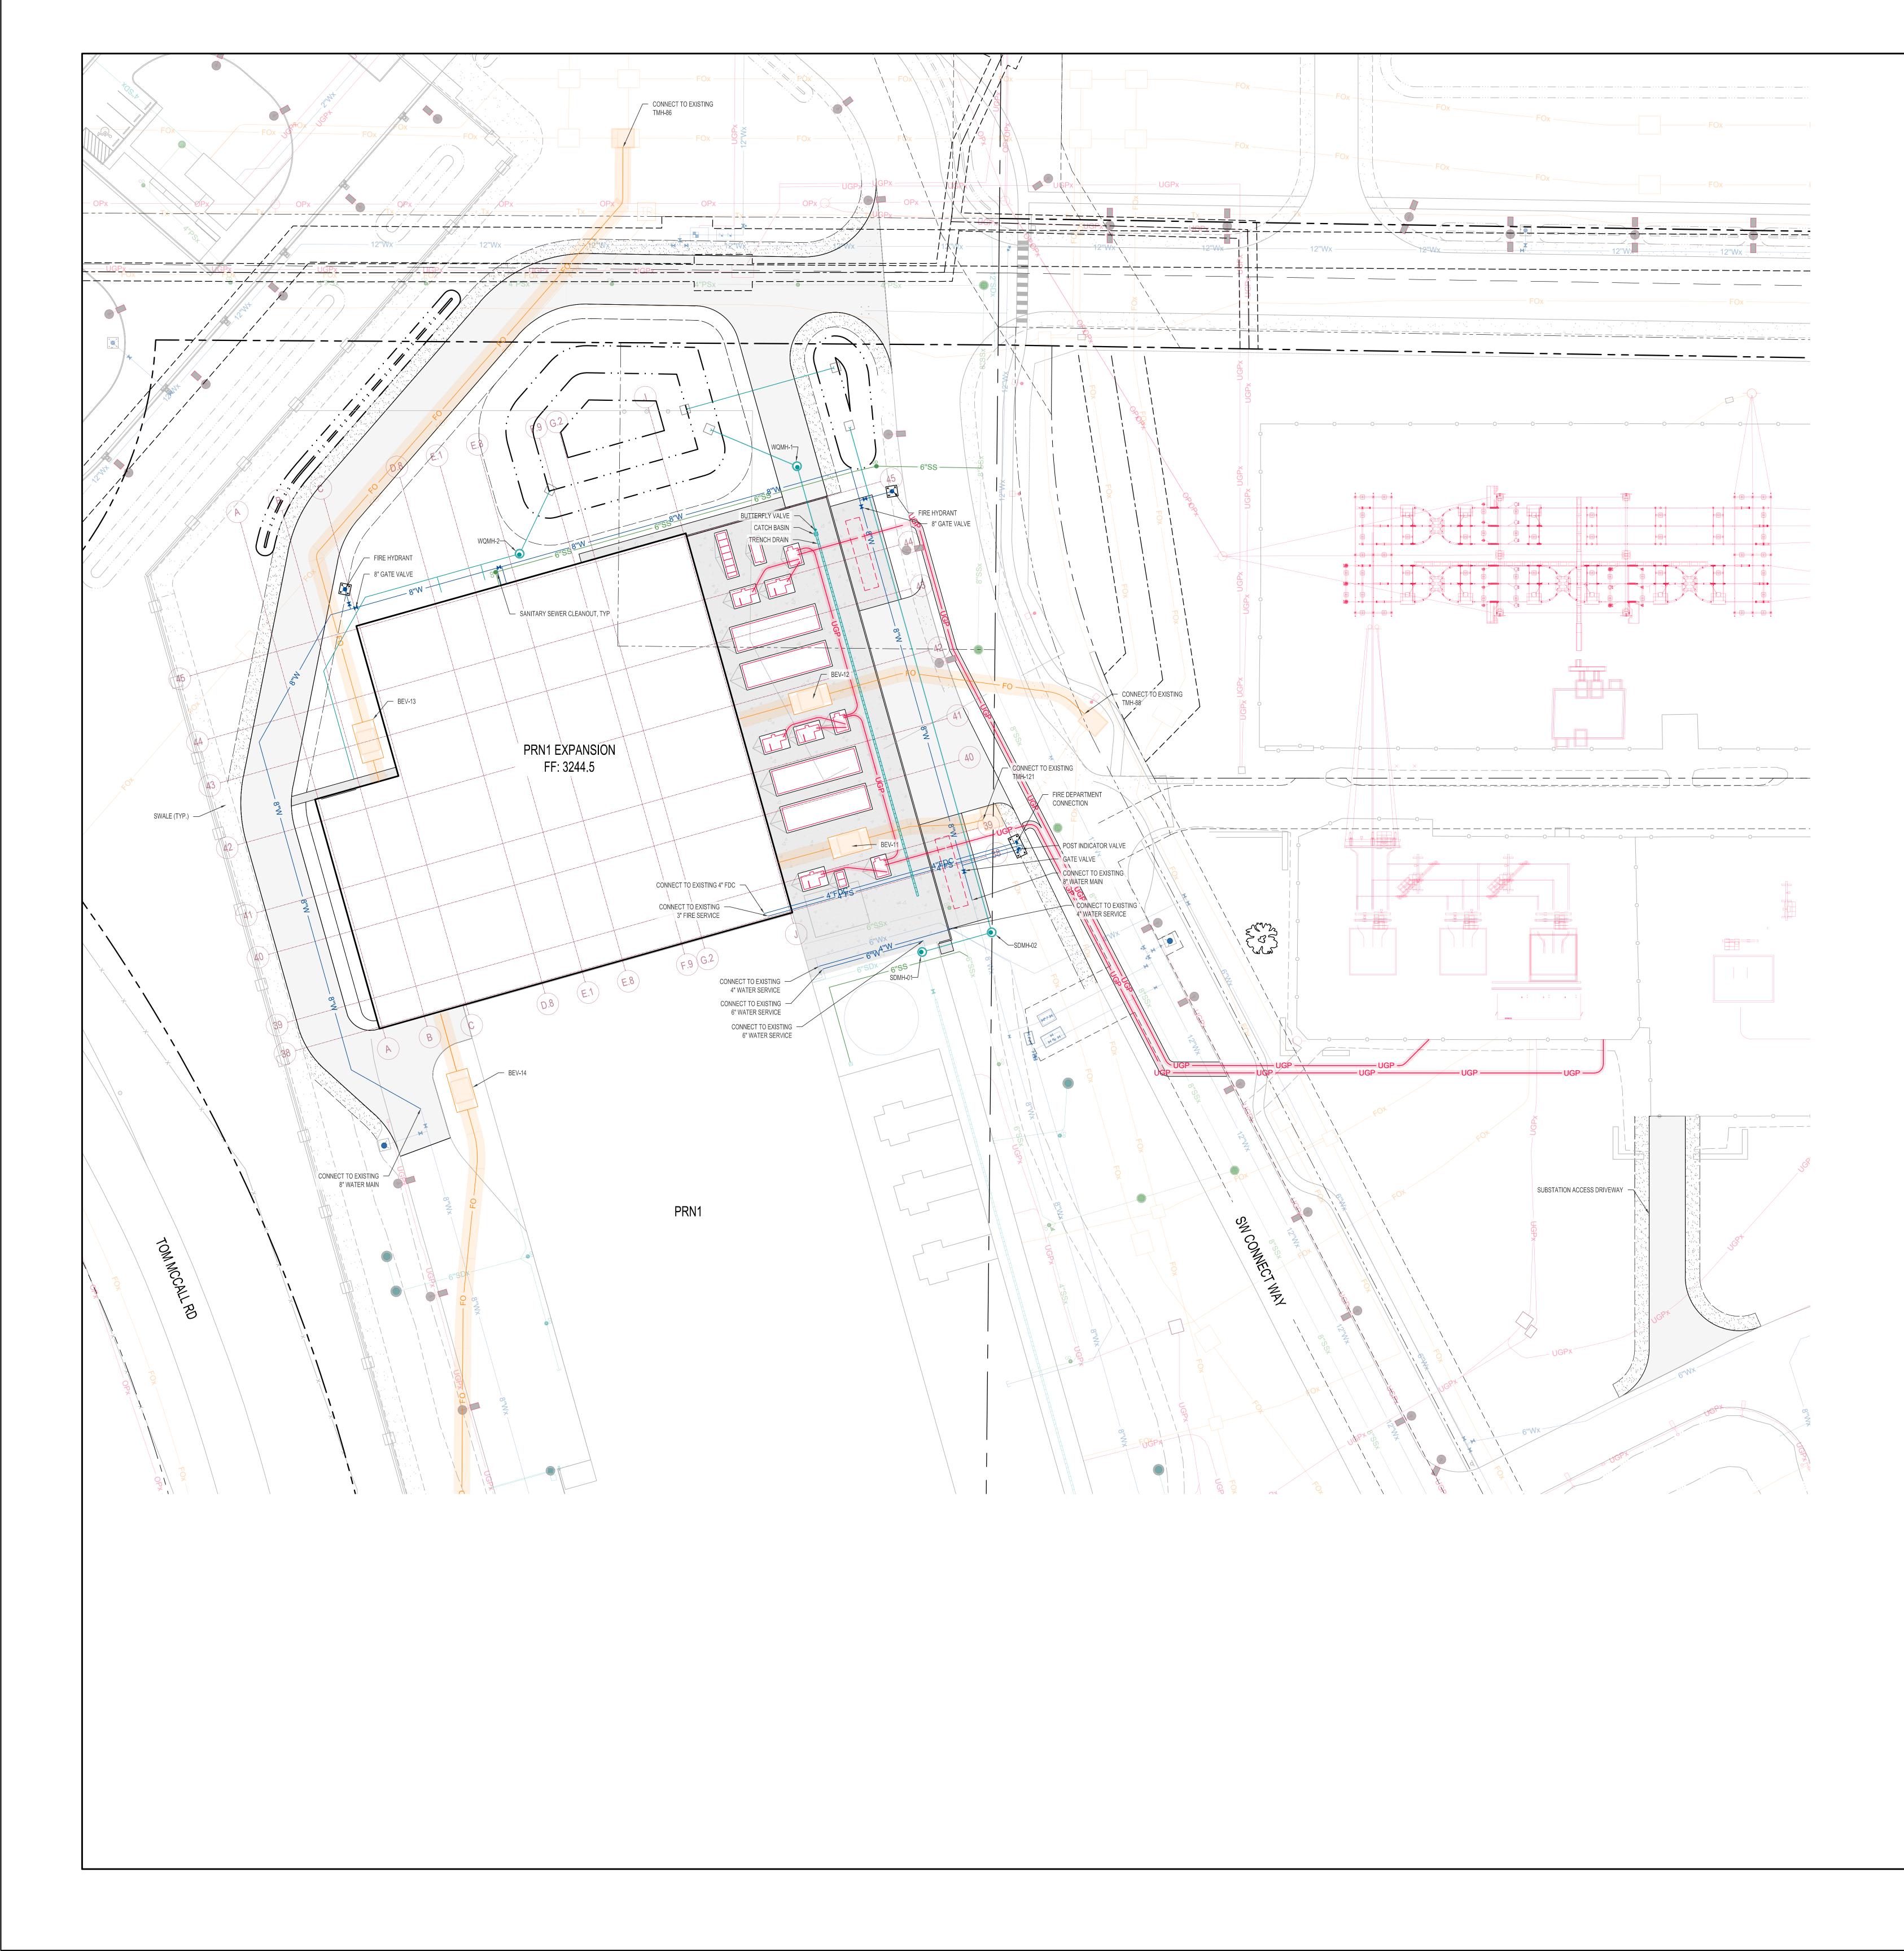


OWNER		
FACEE	800	К
MEP ENGINEER		
<b>MES</b>		
Environmental Syst	tems Design	n, Inc.
ARCHITECT		
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PEOPLES AS STRUCTURAL		-
TECHNOLOGY CONSULTANT		
	G	S
CIVIL ENGINEER Parametrix		
ENGINEERING . PLANNING . ENVIRONME	ENTAL SCIENCES	
LANDSCAPE ARCHITECT		
	Landscape Architecture Masterplanning Environmental Design 115 Washington Avenue North	
	Suite 200 Minnwepolik, NN 35410 612-359-91-4 130 East Randolph Street Suite 3100 Chikago, IL 66601	
SUBSTATION ENGINEER		
PATR	ICK	
No. Description	1	Date
100% DESIGN DEVELOPMENT 50% DESIGN DEVELOPMENT		07.20.2021 06.30.2021
100% SCHEMATIC DESIGN 50% SCHEMATIC DESIGN PROJECT ISSUANCES		05.20.2021 04.08.2021
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DATE: JULY 20, 2021 SCALE:	C10 <sup>4</sup>	1.1
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	<b>.</b>	

## Exhibit C

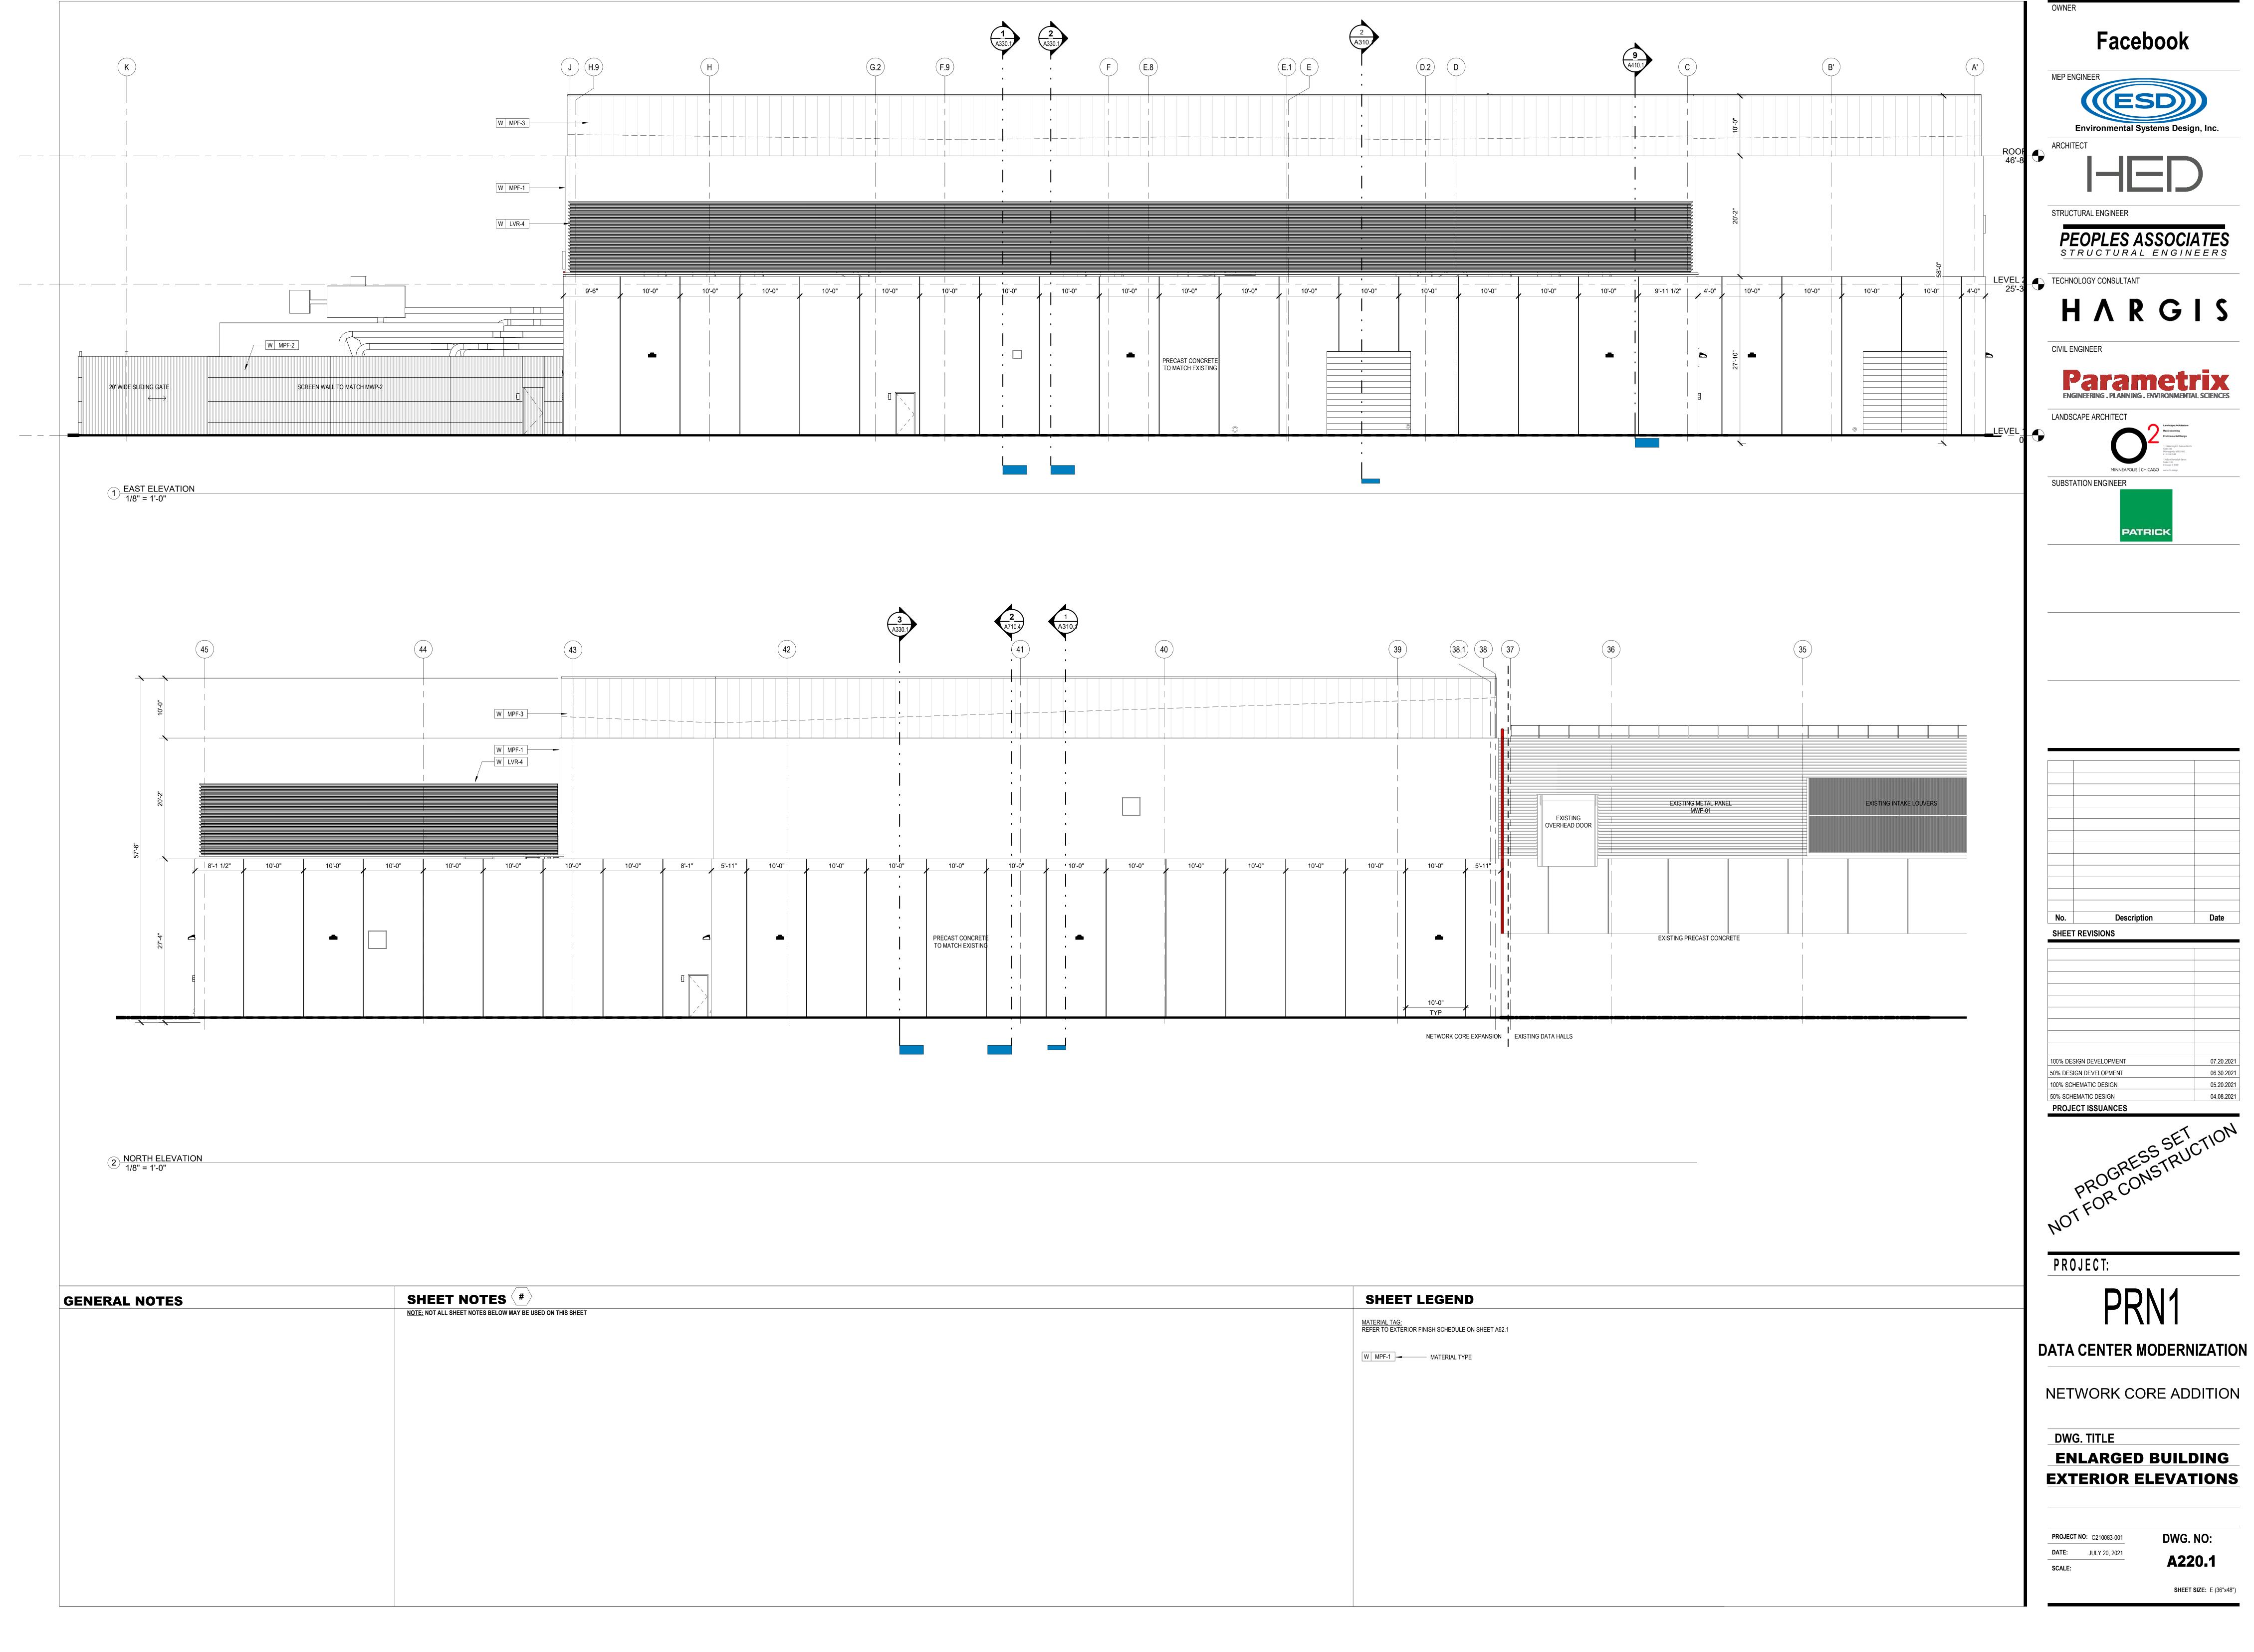


SHEET LEGEND
MATERIAL TAG: REFER TO EXTERIOR FINISH SCHEDULE ON SHEET A62.1
W MPF-1 — MATERIAL TYPE

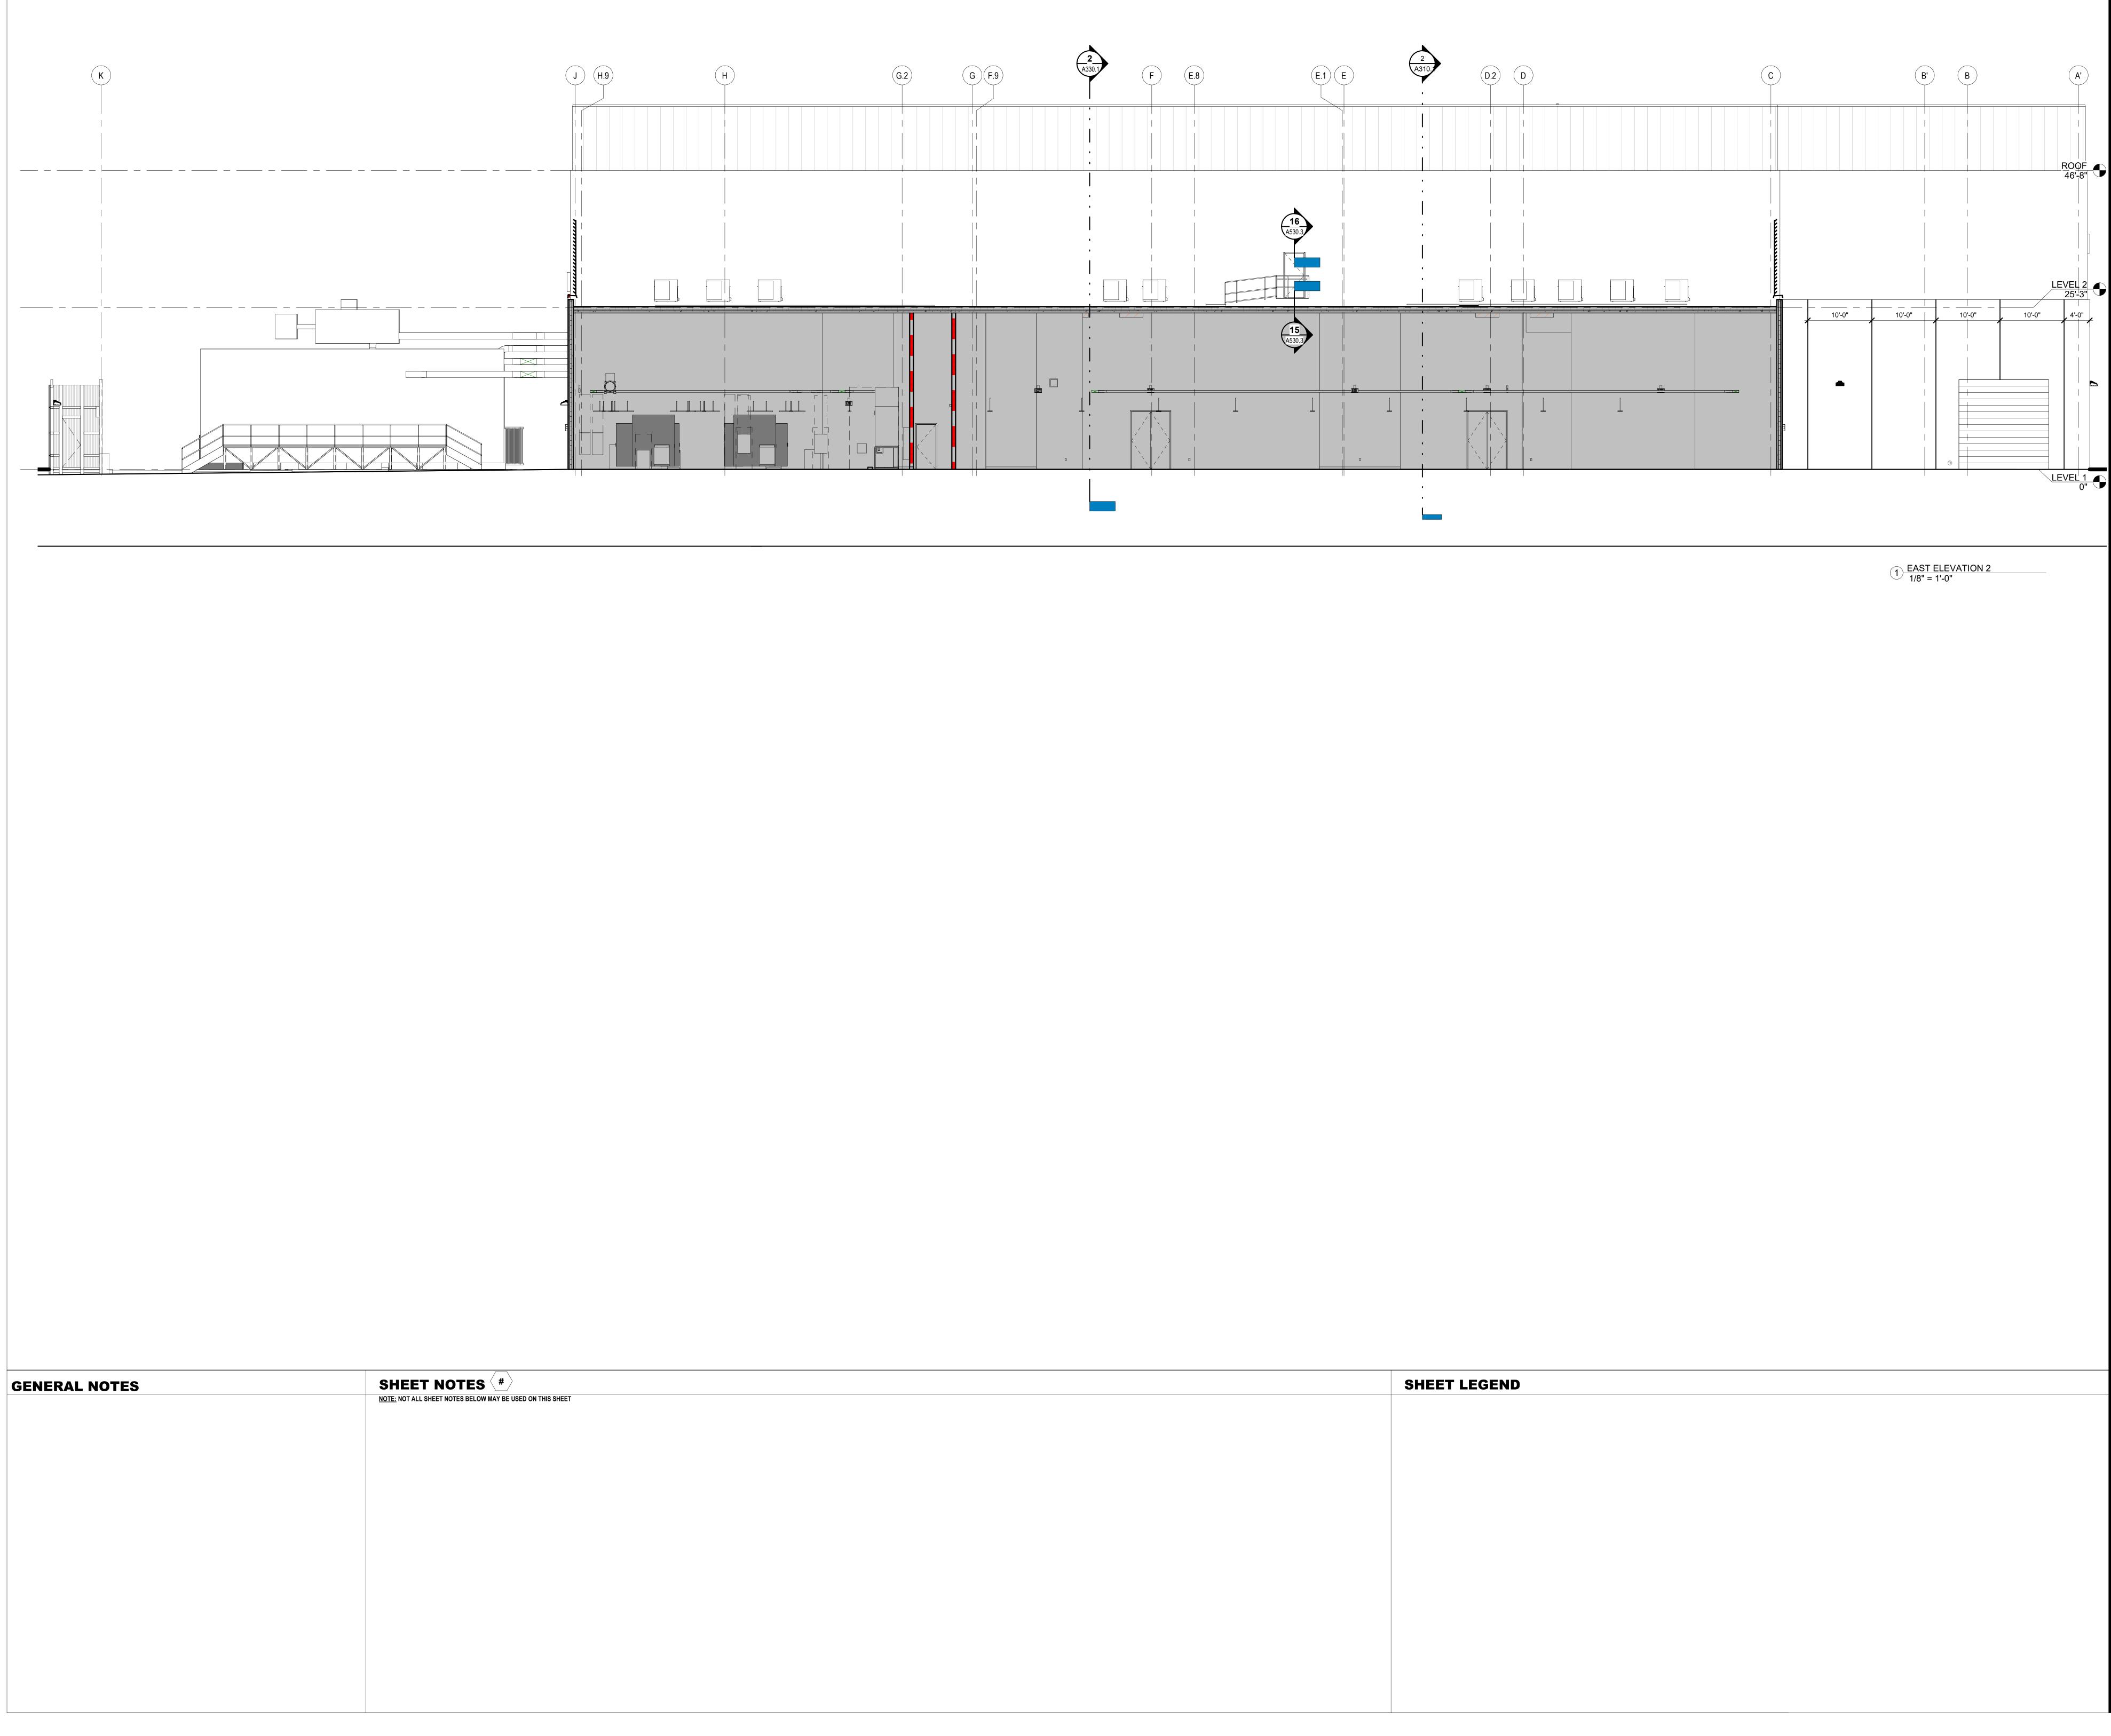

SHEET LEGEND



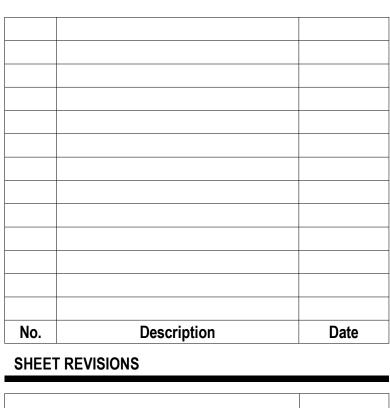

100% DESIGN DEVELOPMENT	07.20.2021

PROJECT ISSUANCES

PROGRESS SEICTIC FOR CONSTRUCTIC

PROJECT:

PRN1

# DATA CENTER MODERNIZATION

NETWORK CORE ADDITION

DWG. TITLE
ENLARGED BUILDING
<b>EXTERIOR ELEVATIONS</b>

PROJECT NO: C210083-001 DWG. NO: **DATE:** JULY 20, 2021 A220.2 SCALE: 0' 2' 4' 6' 8' 12' 16' SCALE: 1/8" =1'-0" SHEET SIZE: E (36"x48")



SHEET LEGEND	
MATERIAL TAG: REFER TO EXTERIOR FINISH SCHEDULE ON SHEET A62.1	
W MPF-1 — MATERIAL TYPE	

Facebook	
MEP ENGINEER	
Environmental Systems Design, Inc.	
ARCHITECT	
HED	
STRUCTURAL ENGINEER	
<b>PEOPLES ASSOCIATES</b> structural engineers	
TECHNOLOGY CONSULTANT	
HARGIS	
CIVIL ENGINEER	
Parametrix Engineering. Planning. Environmental sciences	
MINNEAPOLIS CHICAGO www.calesjon	
SUBSTATION ENGINEER	
PATRICK	

No.	Description	Date
SHEET	REVISIONS	

100% DESIGN DEVELOPMENT	07.20.2021
50% DESIGN DEVELOPMENT	06.30.2021
100% SCHEMATIC DESIGN	05.20.2021
50% SCHEMATIC DESIGN	04.08.2021
PROJECT ISSUANCES	

PROGRESS SEICTIC FOR CONSTRUCTIC

PROJECT:

# PRN1

# DATA CENTER MODERNIZATION


NETWORK CORE ADDITION

DWG. TITLE
ENLARGED BUILDING
<b>EXTERIOR ELEVATIONS</b>

PROJECT NO: C210083-001 **DATE:** JULY 20, 2021 SCALE:


DWG. NO: A220.3

SHEET SIZE: E (36"x48")

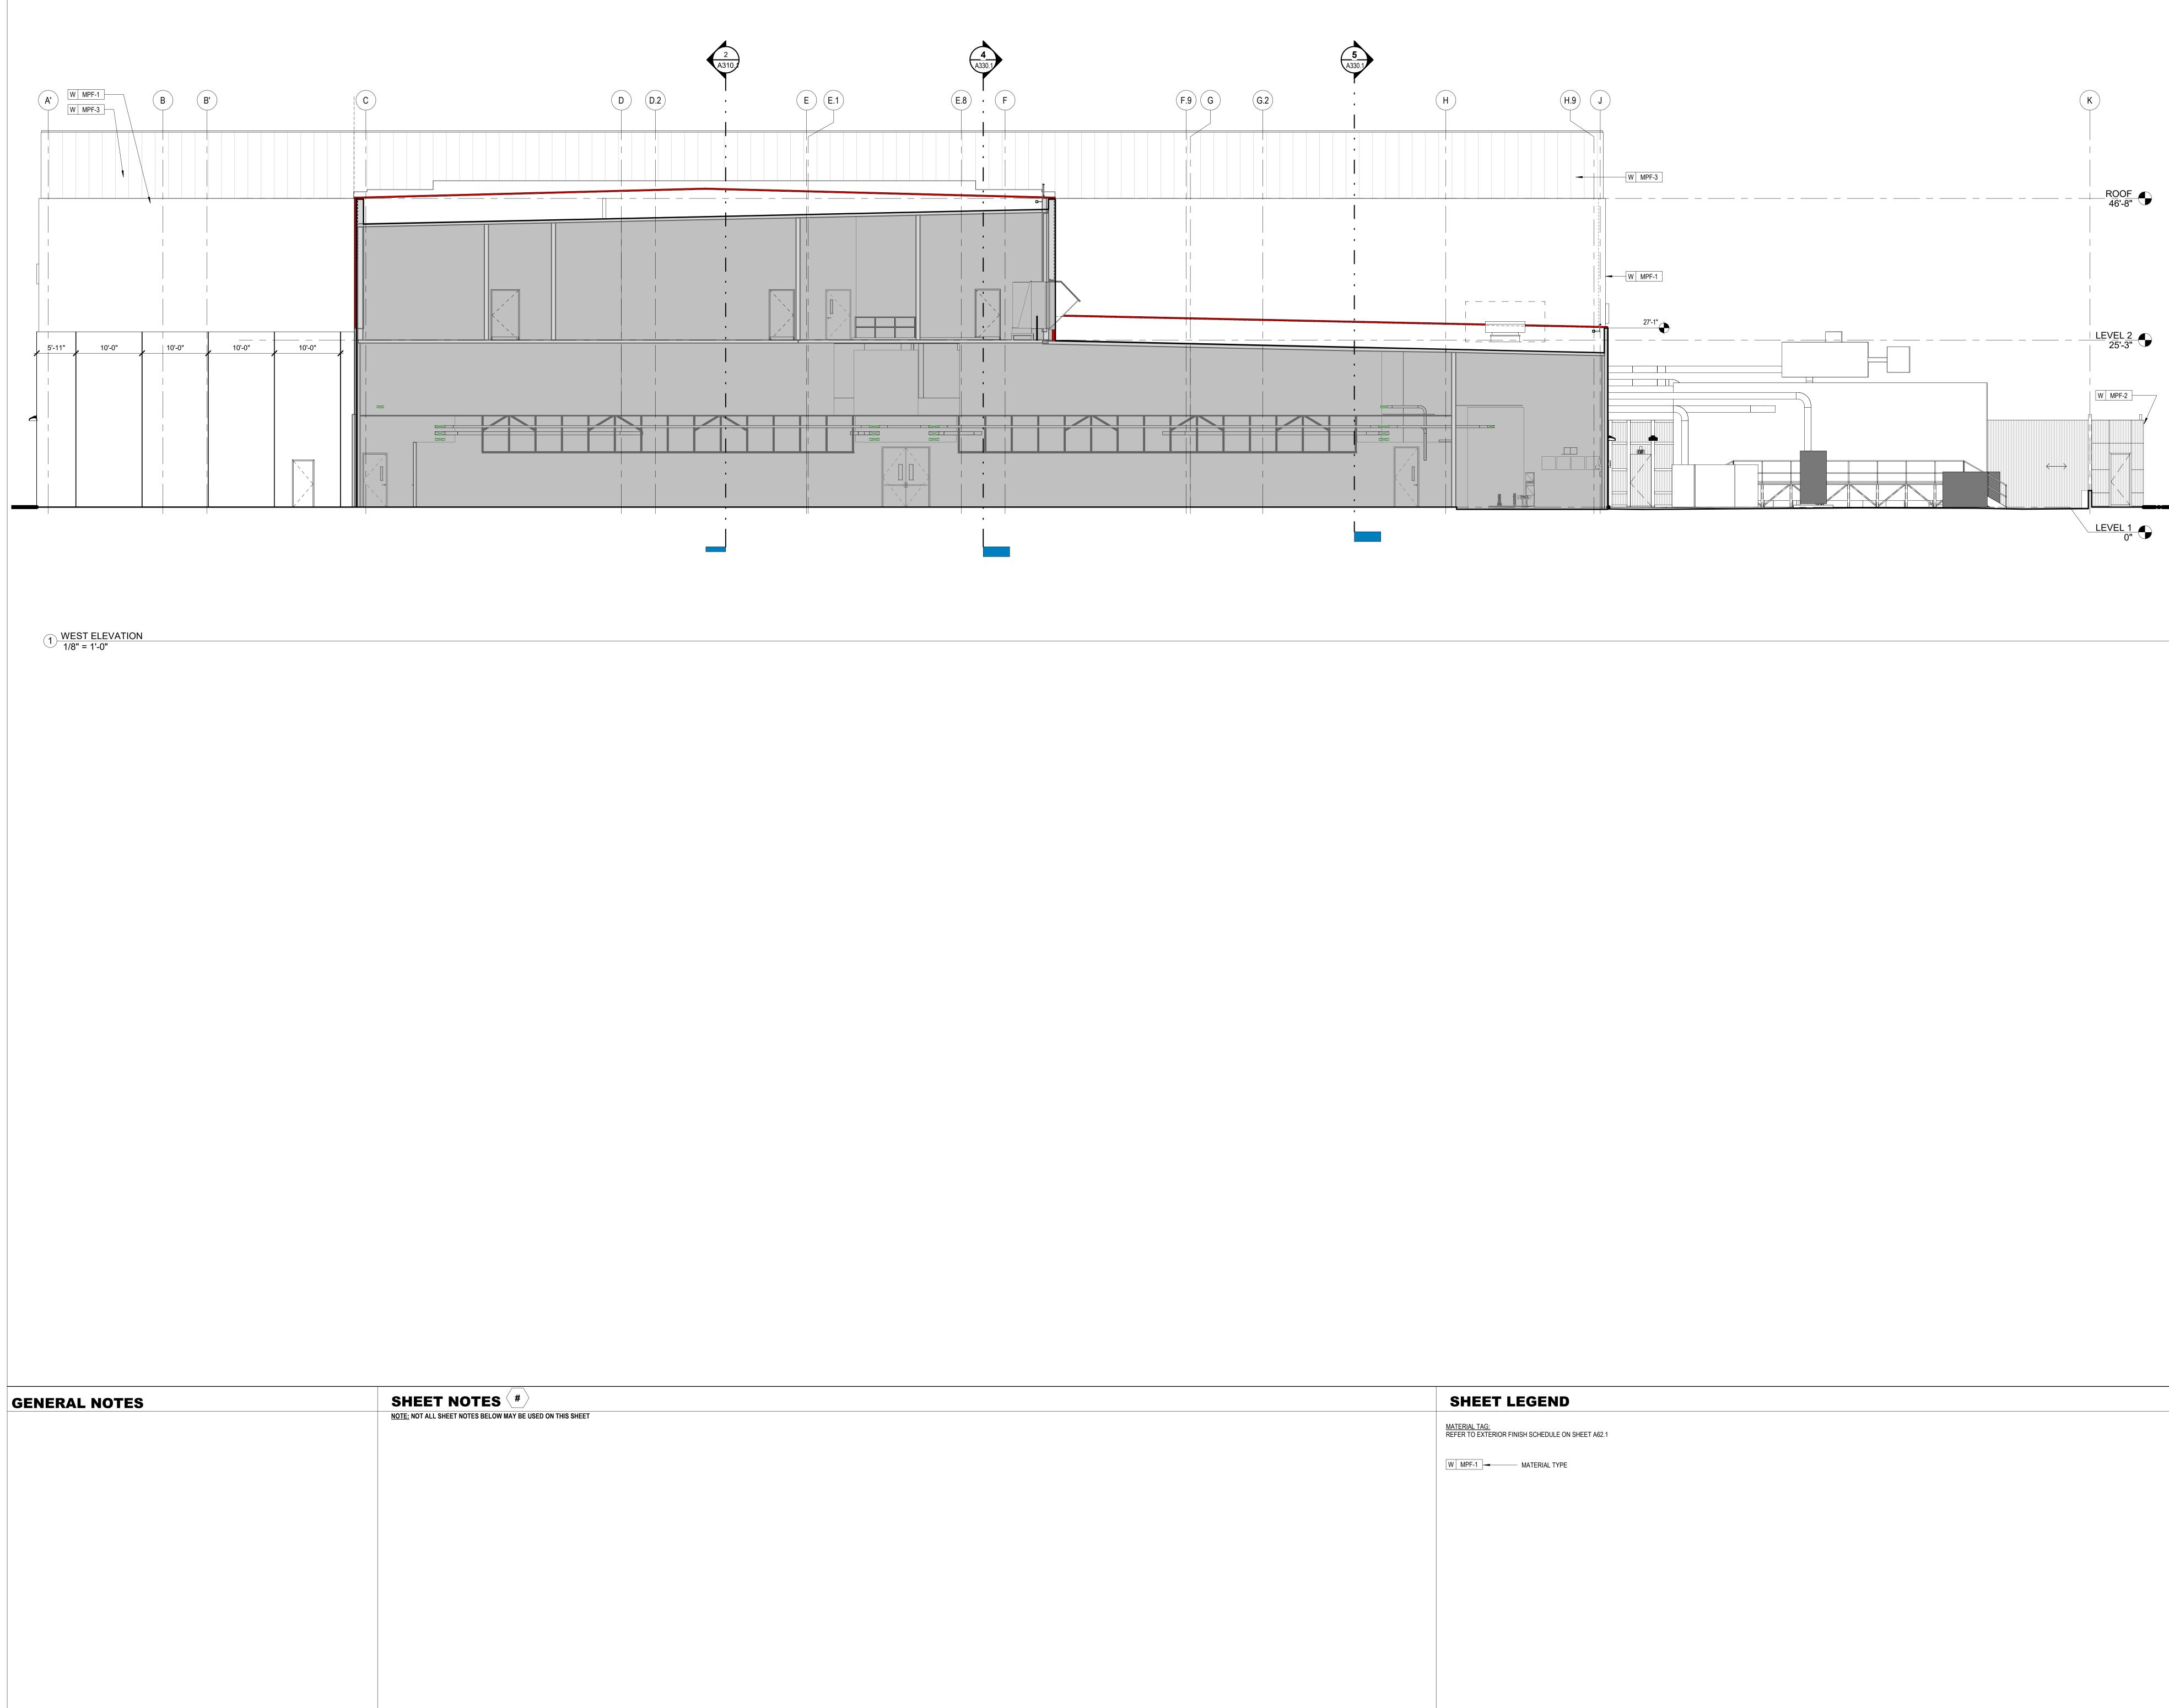

SHEET LEGEND
MATERIAL TAG: REFER TO EXTERIOR FINISH SCHEDULE ON SHEET A62.1
W MPF-1 — MATERIAL TYPE



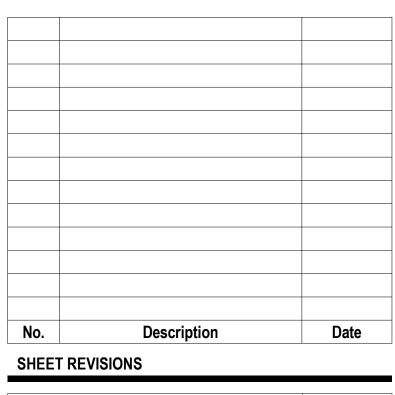

100% DESIGN DEVELOPMENT	07.20.2021
50% DESIGN DEVELOPMENT	06.30.2021
100% SCHEMATIC DESIGN	05.20.2021

PROJECT ISSUANCES

PROGRESS SEICTIC FOR CONSTRUCTIC

PROJECT:

PRN1

# DATA CENTER MODERNIZATION

NETWORK CORE ADDITION

DWG. TITLE
ENLARGED BUILDING
<b>EXTERIOR ELEVATIONS</b>

PROJECT NO: C210083-001 **DATE:** JULY 20, 2021 SCALE:

DWG. NO: A220.4

SHEET SIZE: E (36"x48")